## AUTOMATIC TRANSFER SWITCH

REPLACEMENT FOR

## SOMERS HIGH SCHOOL

SOMERS, CT


SEPTEMBER 1, 2023


FACILITY SERVICES & ENGINEERING, INC.

42 RIDGEBROOK DRIVE


COVENTRY, CT

(860) 742-4170

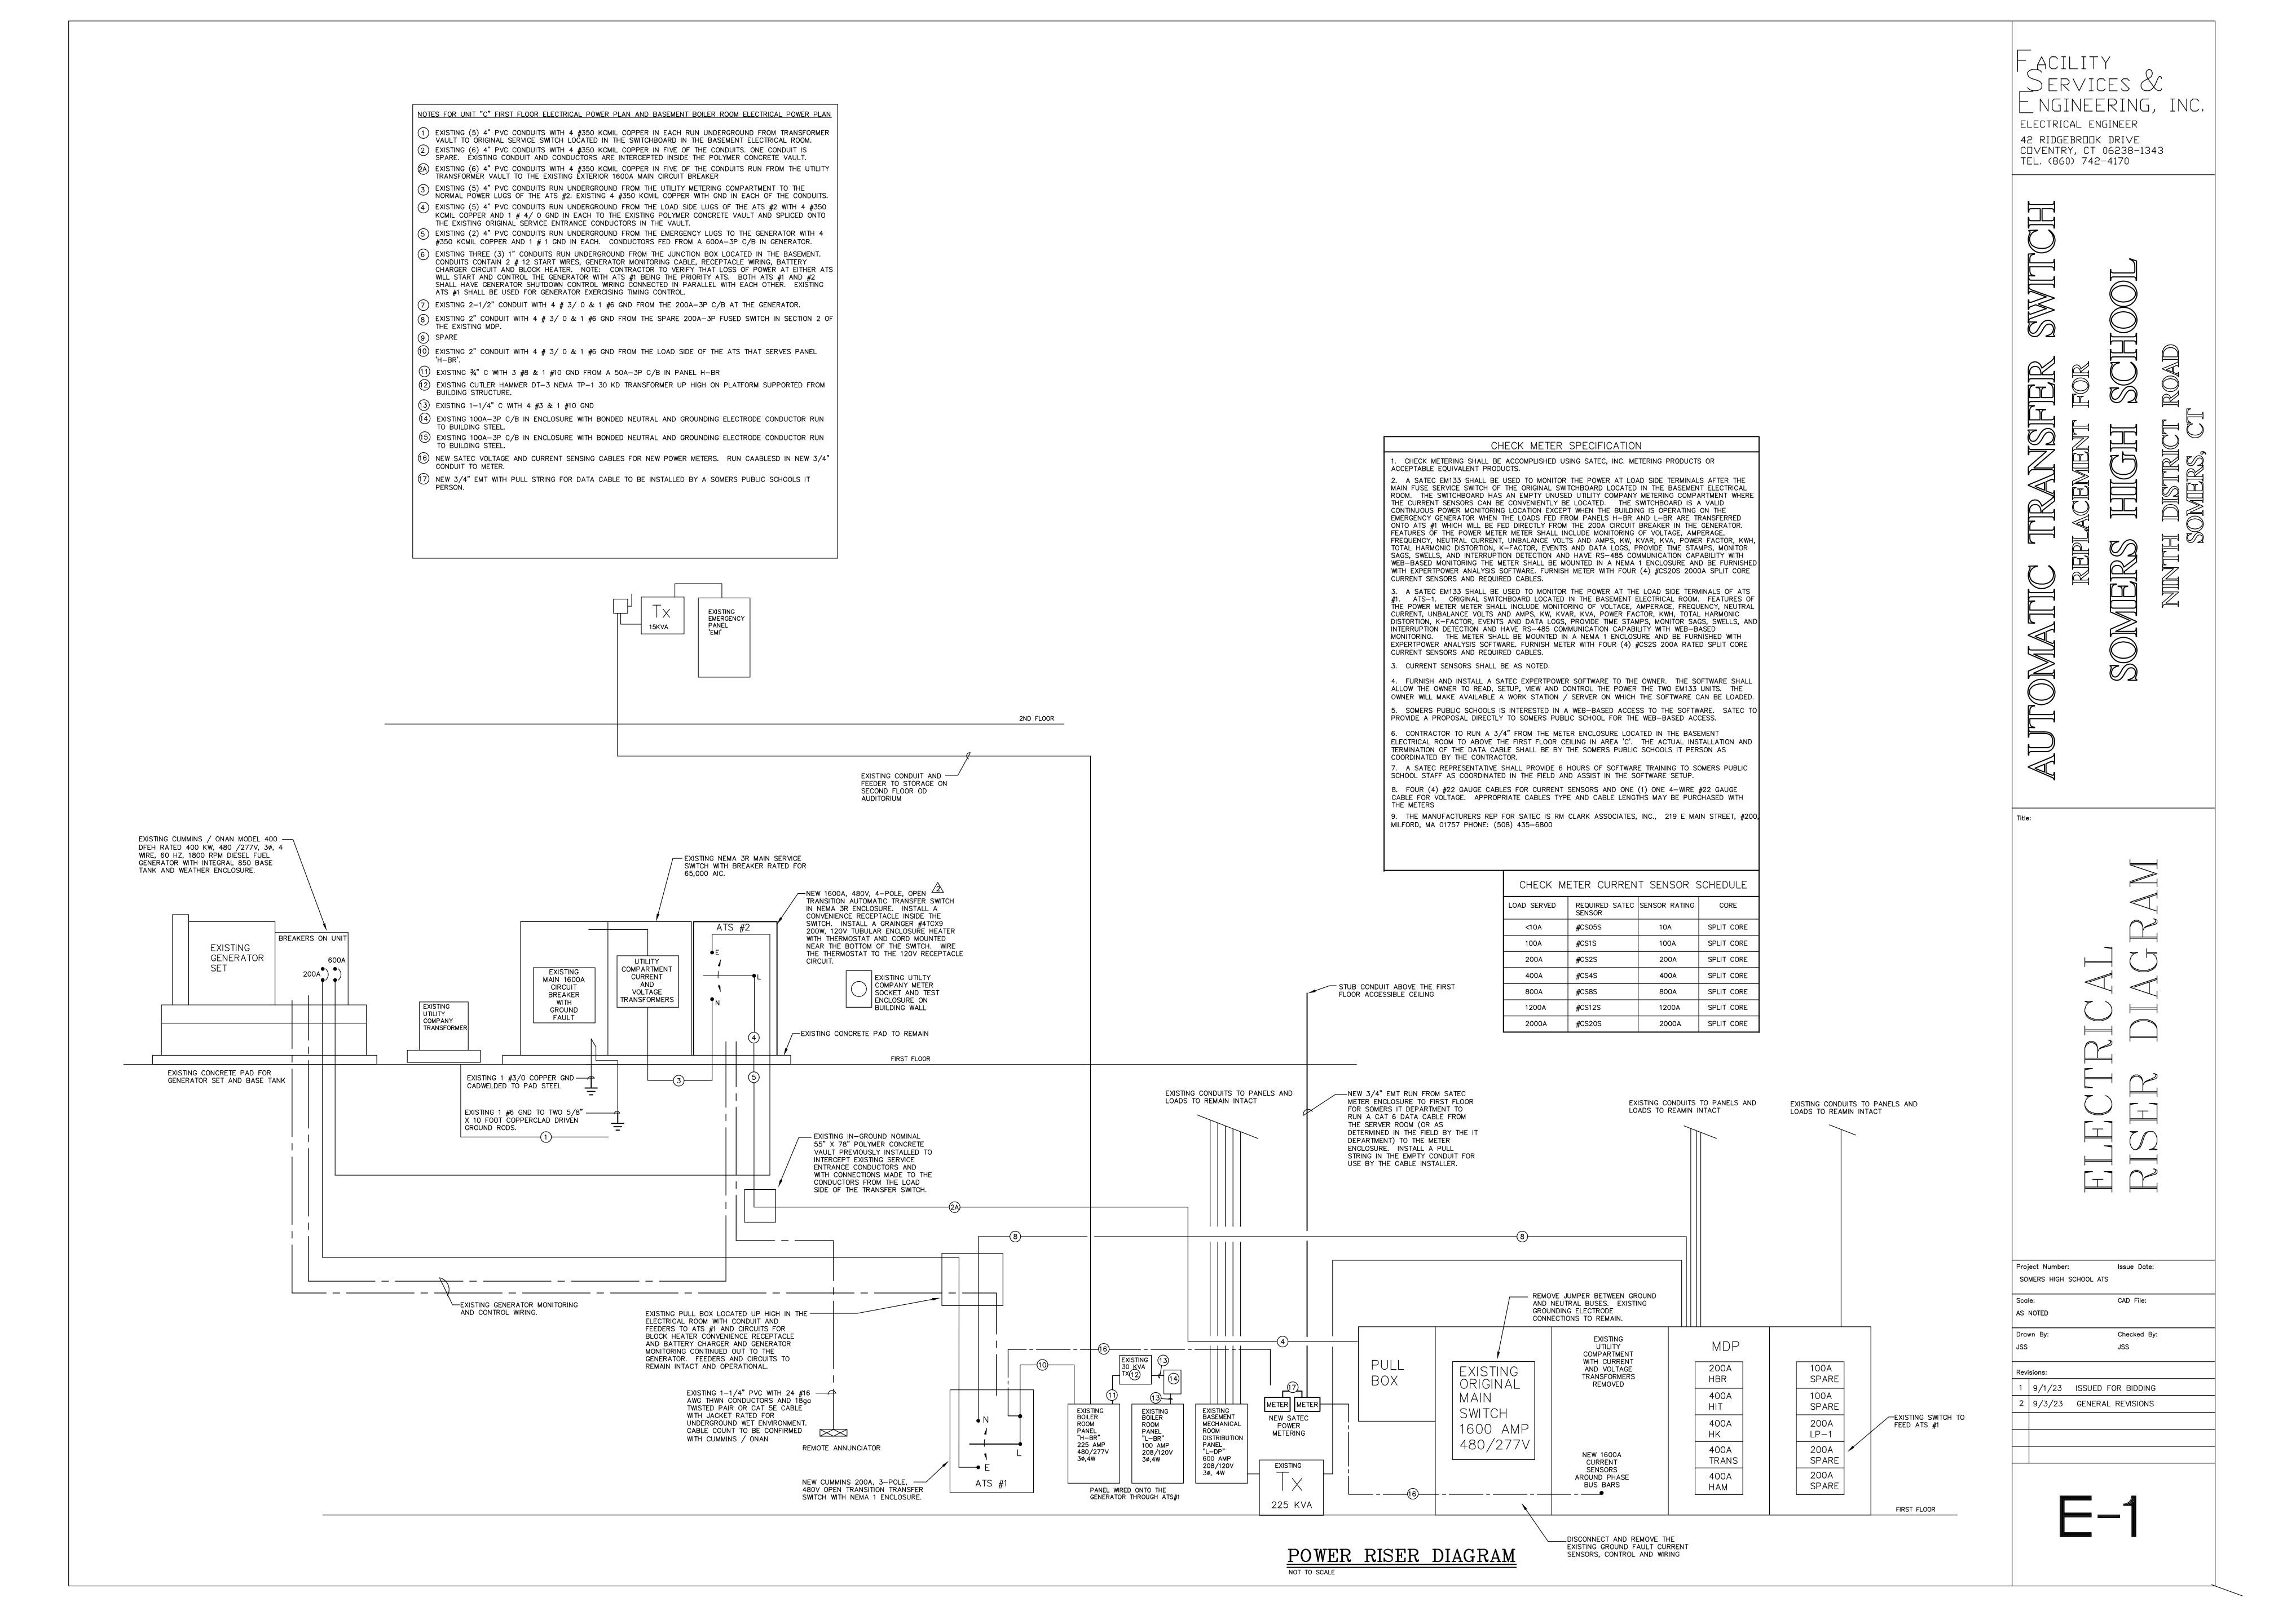

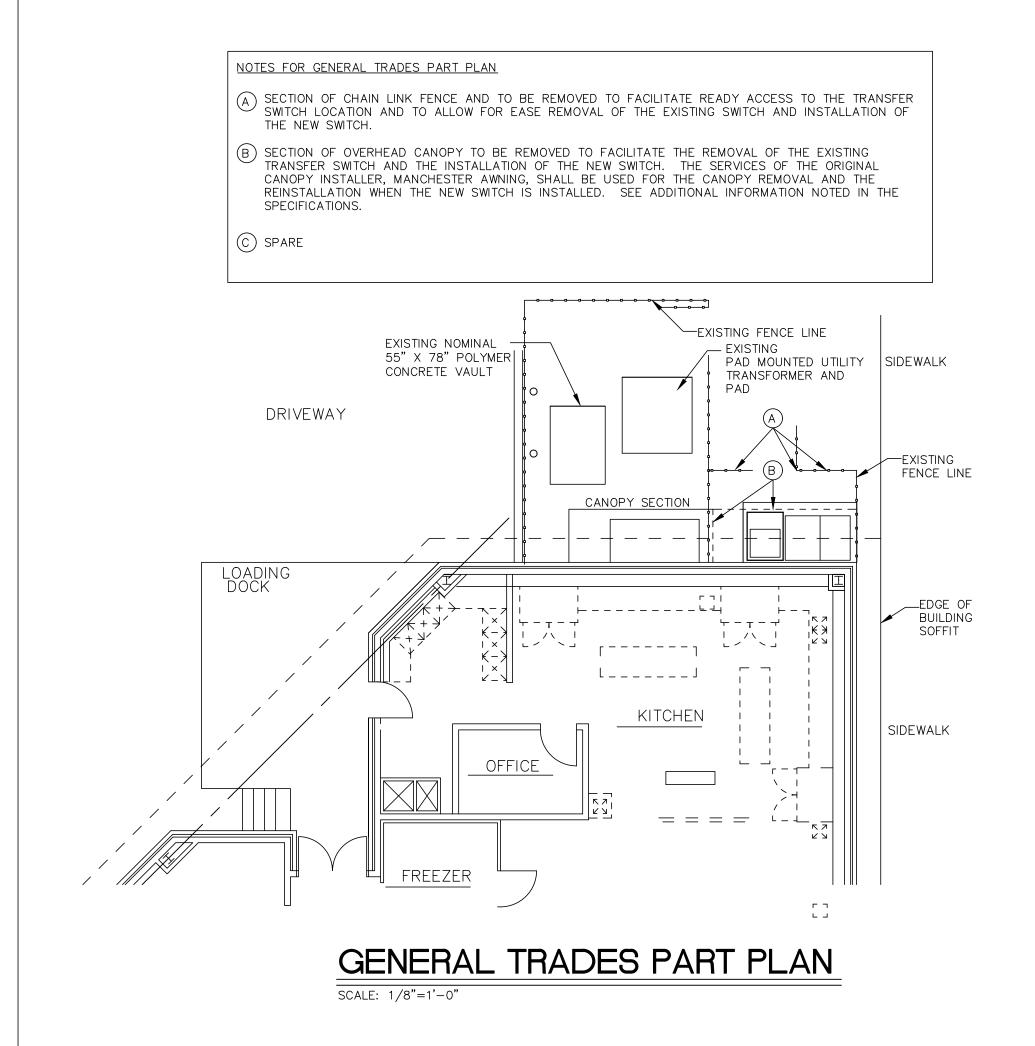


NOTES FOR UNIT "C" FIRST FLOOR ELECTRICAL POWER PLAN AND BASEMENT BOILER ROOM ELECTRICAL POWER PLAN 1 EXISTING (5) 4" PVC CONDUITS WITH 4 #350 KCMIL COPPER IN EACH RUN UNDERGROUND FROM TRANSFORMER VAULT TO ORIGINAL SERVICE SWITCH LOCATED IN THE SWITCHBOARD IN THE BASEMENT ELECTRICAL ROOM. (2) EXISTING (6) 4" PVC CONDUITS WITH 4 #350 KCMIL COPPER IN FIVE OF THE CONDUITS. ONE CONDUIT IS SPARE. ÈXÍSTING CONDUIT AND CONDUCTORS ARE INTERCEPTED INSIDE THE POLYMER CONCRETE VAULT. (6) 4" PVC CONDUITS WITH 4 #350 KCMIL COPPER IN FIVE OF THE CONDUITS RUN FROM THE UTILITY TRANSFORMER VAULT TO THE EXISTING EXTERIOR 1600A MAIN CIRCUIT BREAKER  $\widehat{\mathfrak{Z}}$  EXISTING (5) 4" PVC CONDUITS RUN UNDERGROUND FROM THE UTILITY METERING COMPARTMENT TO THE NORMAL POWER LUGS OF THE ATS #2. EXISTING 4 #350 KCMIL COPPER WITH GND IN EACH OF THE CONDUITS. (4) EXISTING (5) 4" PVC CONDUITS RUN UNDERGROUND FROM THE LOAD SIDE LUGS OF THE ATS #2 WITH 4 #350 KCMIL COPPER AND 1 # 4/ 0 GND IN EACH TO THE EXISTING POLYMER CONCRETE VAULT AND SPLICED ONTO THE EXISTING ORIGINAL SERVICE ENTRANCE CONDUCTORS IN THE VAULT. (5) EXISTING (2) 4" PVC CONDUITS RUN UNDERGROUND FROM THE EMERGENCY LUGS TO THE GENERATOR WITH 4 #350 KCMIL COPPER AND 1 # 1 GND IN EACH. CONDUCTORS FED FROM A 600A-3P C/B IN GENERATOR.  $\stackrel{\frown}{6}$ ) EXISTING THREE (3) 1" CONDUITS RUN UNDERGROUND FROM THE JUNCTION BOX LOCATED IN THE BASEMENT. CONDUITS CONTAÎN 2 # 12 START WIRES, GENERATOR MONITORING CABLE, RECEPTACLE WIRING, BATTERY CHARGER CIRCUIT AND BLOCK HEATER. NOTE: CONTRACTOR TO VERIFY THAT LOSS OF POWER AT EITHER ATS WILL START AND CONTROL THE GENERATOR WITH ATS #1 BEING THE PRIORITY ATS. BOTH ATS #1 AND #2 SHALL HAVE GENERATOR SHUTDOWN CONTROL WIRING CONNECTED IN PARALLEL WITH EACH OTHER. EXISTING ATS #1 SHALL BE USED FOR GENERATOR EXERCISING TIMING CONTROL. (7) EXISTING 2-1/2" CONDUIT WITH 4 # 3/ 0 & 1 #6 GND FROM THE 200A-3P C/B AT THE GENERATOR. 8 EXISTING 2" CONDUIT WITH 4 # 3/ 0 & 1 #6 GND FROM THE SPARE 200A-3P FUSED SWITCH IN SECTION 2 OF THE EXISTING MDP. D) EXISTING 2" CONDUIT WITH 4 # 3/ 0 & 1 #6 GND FROM THE LOAD SIDE OF THE ATS THAT SERVES PANEL 11) EXISTING 34" C WITH 3 #8 & 1 #10 GND FROM A 50A-3P C/B IN PANEL H-BR (12) EXISTING CUTLER HAMMER DT-3 NEMA TP-1 30 KD TRANSFORMER UP HIGH ON PLATFORM SUPPORTED FROM BUILDING STRUCTURE. (13) EXISTING 1-1/4" C WITH 4 #3 7 1 # 10 GND (4) EXSTING 100A-3P C/B IN ENCLOSURE. BOND NEUTRAL AND GROUNDING ELECTRODE CONDUCTOR FOR SEPARATELY DERIVED SYSTEM. RUN A #6 GROUNDING ELECTRODE CONDUCTOR TO BUILDING STEEL. (6) EXISTING VERTICAL OIL TANK VENT PIPE CAN BE REMOVED. A NEW FUEL OIL TANK WILL BE SURFACE MOUNTED AND VENT PIPE BECOMES OBSOLETE AS PART OF ANOTHER PROJECT.

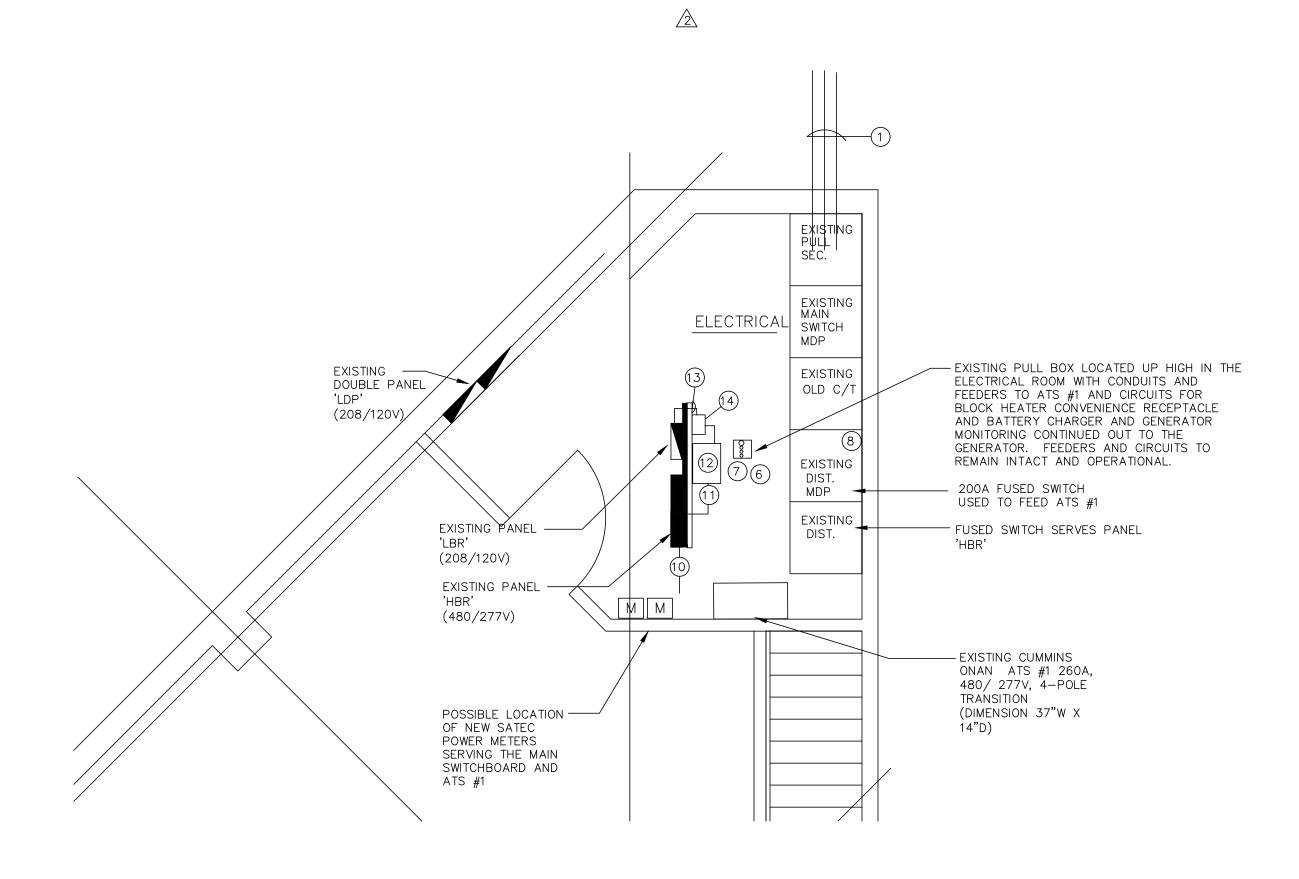

BASEMENT BOILER ROOM ELECTRICAL POWER PLAN

SCALE: 1/4"=1'-0"

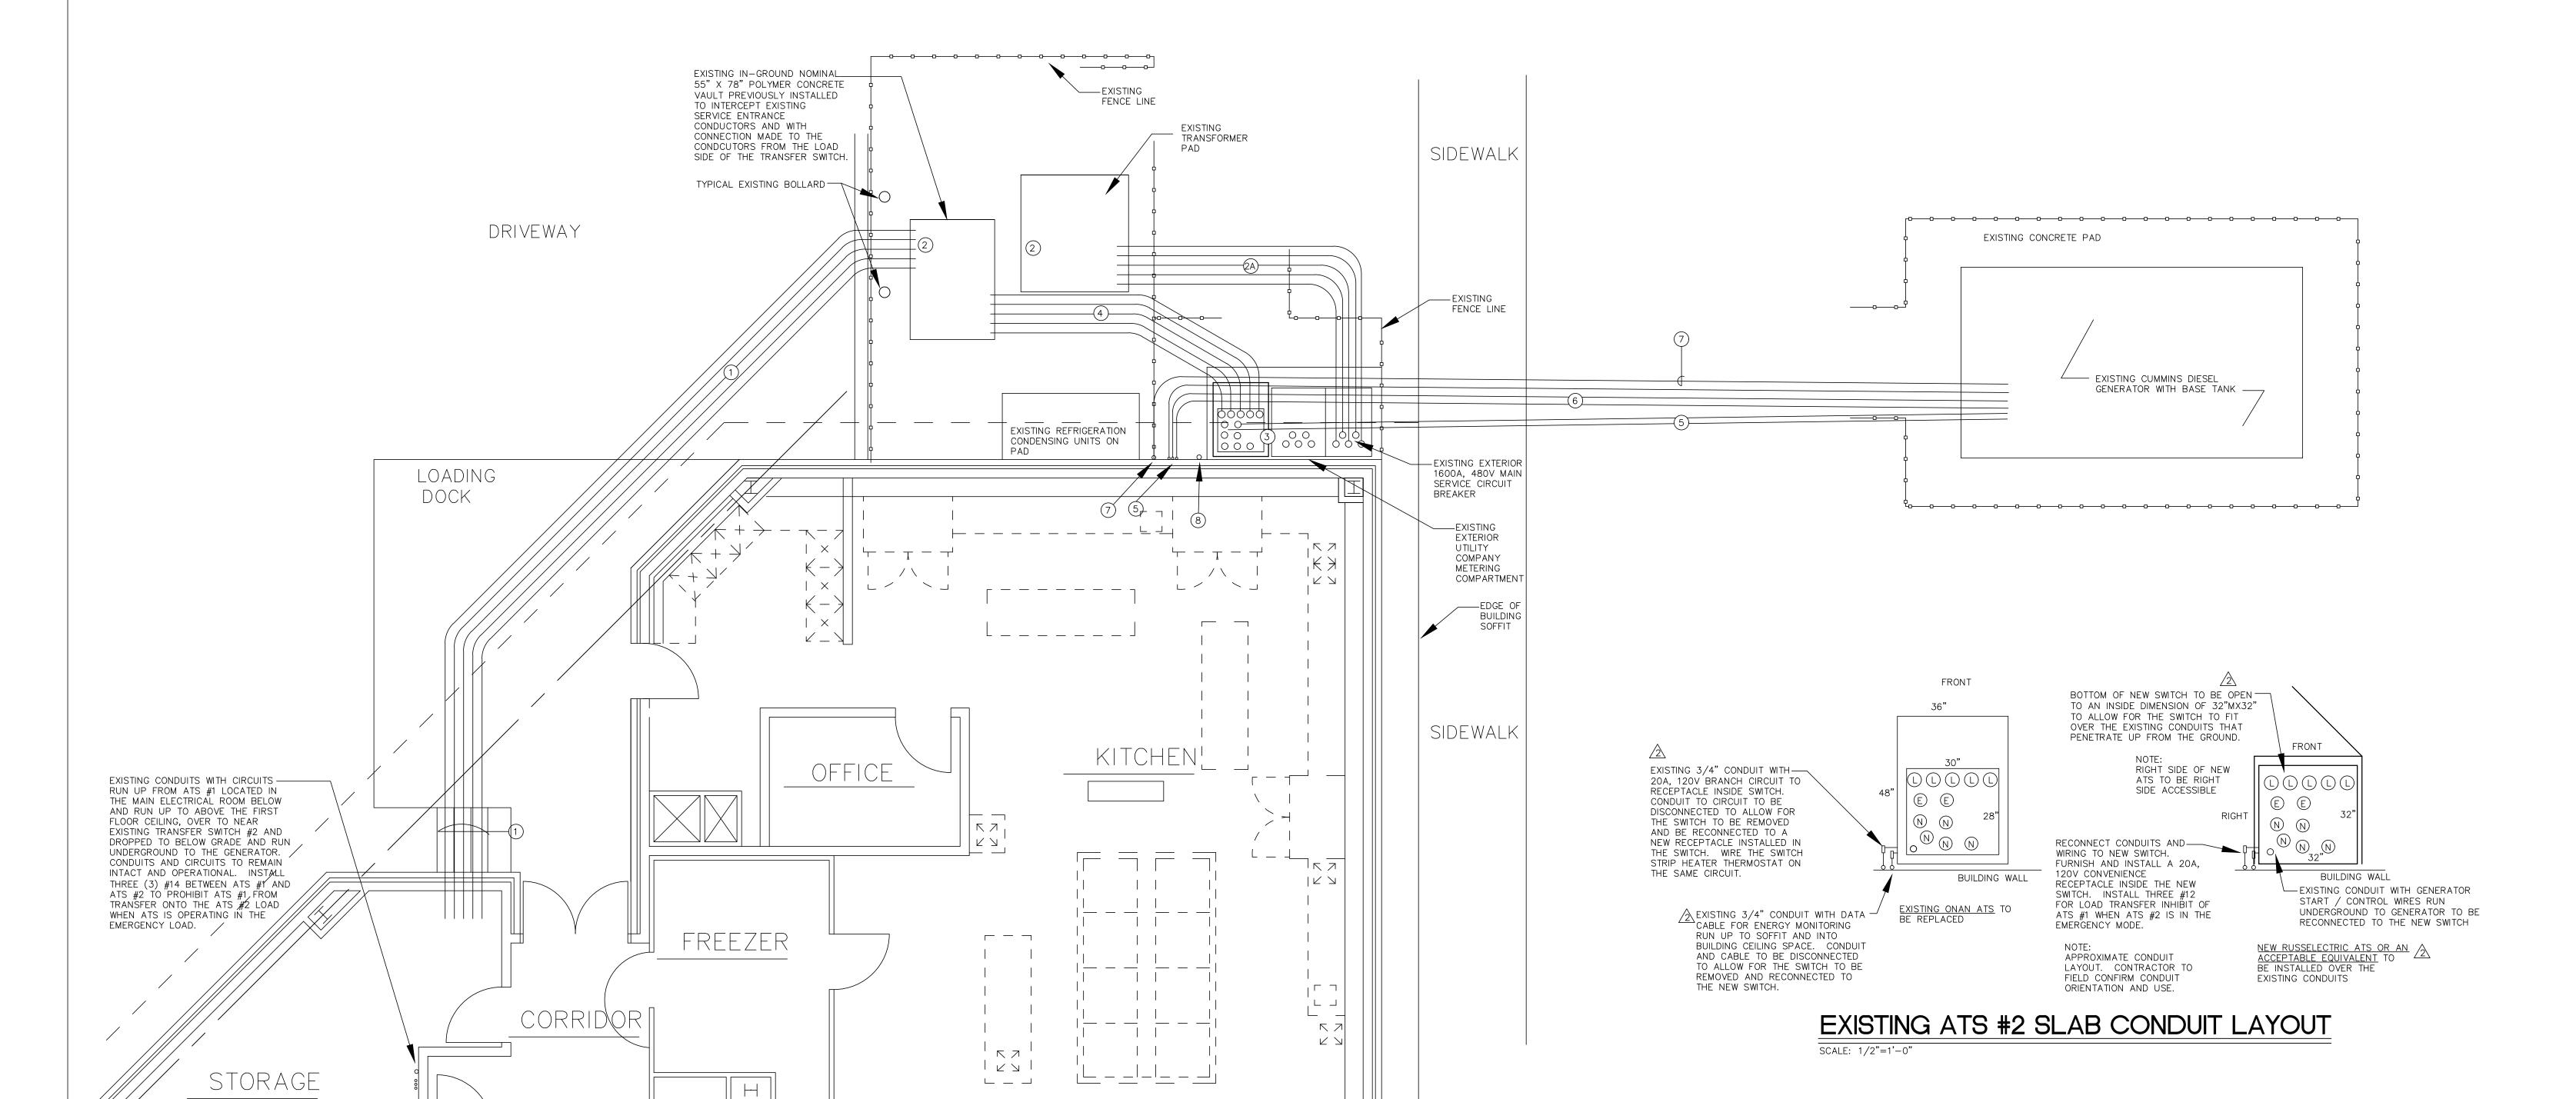

PARTIAL UNIT "C" FIRST FLOOR ELECTRICAL POWER PLAN

SCALE: 1/8"=1'-0"

FACILITY
SERVICES &
ENGINEERING, INC.
ELECTRICAL ENGINEER
42 RIDGEBROOK DRIVE
COVENTRY, CT 06238-1343

TEL. (860) 742-4170

MATIC TRANSFER SWITCH.

REPLACEMENT FOR

SOMERS HIGH SCHOOL

HIRCTRICAL SITH AND ROOM PART PIANS

Project Number: Issue Date:

SOMERS HIGH SCHOOL ATS

Scale: CAD File:

AS NOTED

Drawn By: Checked By:

JSS JSS

Revisions:

1 9/1/23 ISSUED FOR BIDDING2

2 9/3/23 GENERAL REVISIONS